A small housing addition will usually require the submission of the following drawings. All drawings must be accurately drawn to scale, in ink. If the drawings are prepared by someone other than the owner, the designer must have the qualifications specified in the building code.

### SITE PLAN

A SITE PLAN is a drawing showing the complete property and identifying all structures in relation to the property boundaries. A property survey is commonly used as a template for developing the site plan. The site plan should include:

- Scale
- North arrow
- Street location \$ name
- Lot lines \$ dimensions to all buildings
- Existing & proposed buildings
- Proposed changes to existing grade

#### FLOOR PLANS

A FLOOR PLAN is a drawing of the structure as seen as if it is cut horizontally a few feet above the floor line. One floor plan is required for every floor of the house which is affected by the new construction. Each plan shows the interior layout of the level in question as well as providing the structural framing information for the floor or roof above. Floor plans should include:

- Scale
- Use of rooms & spaces (label)
- Dimensions
- Extent of new construction including new work within existing building
- Size, type and location of exterior and interior walls and partitions
- Widths, locations and lintel sizes of all openings
- Location, dimensions and direction of stairs
- References to detailed drawings
- Material specifications or notes
- Heating and ventilation details
- Location of smoke alarms and carbon monoxide detectors

#### ELEVATIONS

ELEVATIONS show the exterior view of each side of the house. Each elevation is identified by the direction it is facing, and should include:

- Scale
- Extent of new \$ existing construction
- Dimensions of walls, windows \$ doors
- Grade level
- Exterior wall cladding, finishes \$ flashing
- Overhang dimensions
- Roof shape, slope \$ finish
- Rain water leader \$ eavestrough

### SECTIONS and DETAILS

A SECTION represents a view of the house along an imaginary line at a particular location, \$ illustrates construction details. The extent of the section should correspond with the sectional arrow shown on the plans. Sections should indicate the following:

- Scale
- Details of footings, foundations, walls, floors \$ the roof
- Distance from grade to floor \$ underside of footing
- Attic & crawl space ventilation


Some aspects of the project may require some specific details, such as engineered roof truss drawings. An inventory of standard construction details is available from your local municipal office, which can be used to augment your plans.



TITL

DRAWING REQUIREMENTS FOR A RESIDENTIAL ADDITION DWG. NO.

A02

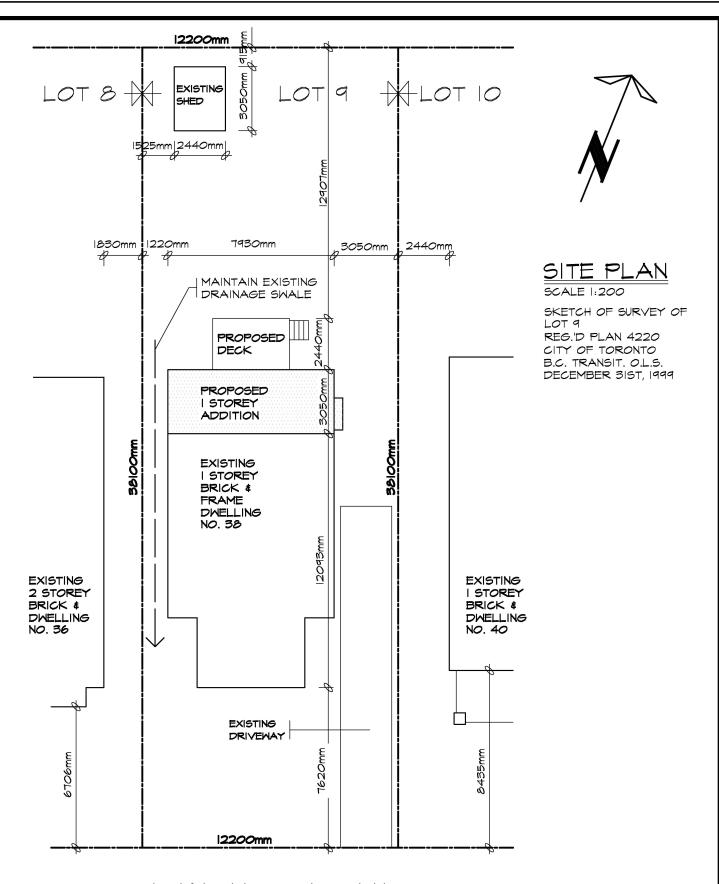

# KHALMUR CRESCENT

<b>ZONING</b> R2 Z0.6  LOT 9			<b>PLAN NO:</b> 4220		. <b>OT AREA</b> 580.64	4m2	LOT FRONTAG	<b>O</b> Omm	LOT DEPTH 38110mm	
DESCRIPTION	EXISTING	ADDITION	TOTAL	%	ALLOWED	%	SETBACKS	EXISTIN	G PROPOSED	
LOT COVERAGE	86.52m2	24.l5m2	110.65m2	19.0			FRONT YARD	7620mm	7620mm	
GROSS FLOOR AREA	86.52m2	24.l5m2	110.65m2	19.0	348.39m2	60.0	REAR			
LANDSCAPED AREA							YARD	18390mm	12907mm	
NO. OF STORIES HEIGHT	I STOREY 4550mm	I STOREY 4550mm	I STOREY 4550mm		10000mm		INTERIOR SIDE (east)	3050mm	3050mm	
WIDTH	7930mm	7930mm	7930mm				INTERIOR SIDE (west)	1220mm	1220mm	
DEPTH	12093mm	3050mm	15143mm		17000mm				1220mm	
PARKING							EXTERIOR			


NOTE: ZONING RESTRICTIONS VARY IN EVERY MUNICIPALITY. CONTACT YOUR LOCAL MUNICIPAL OFFICE FOR SPECIFIC SETBACKS AND OTHER LIMITATIONS IN YOUR AREA.




SAMPLE DRAWING

DWG. NO.




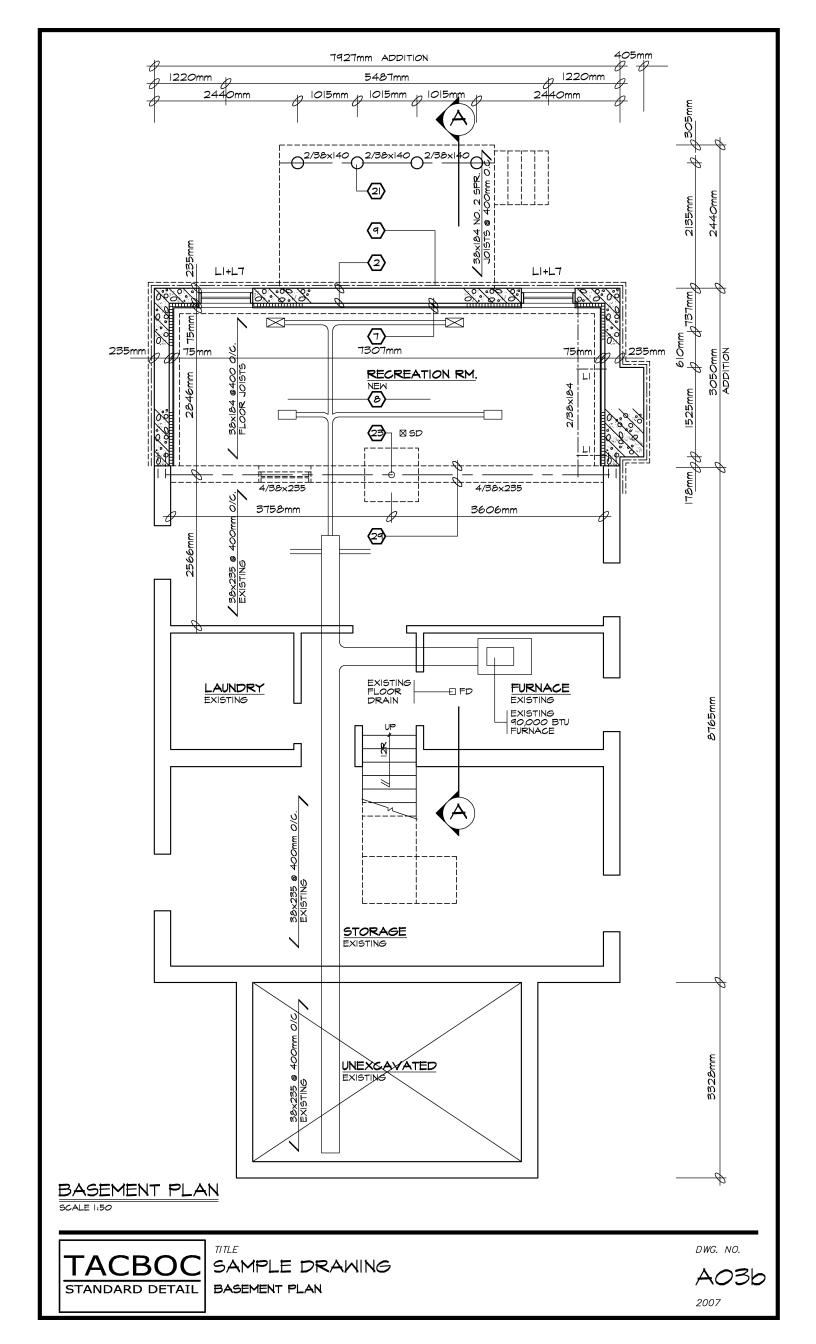

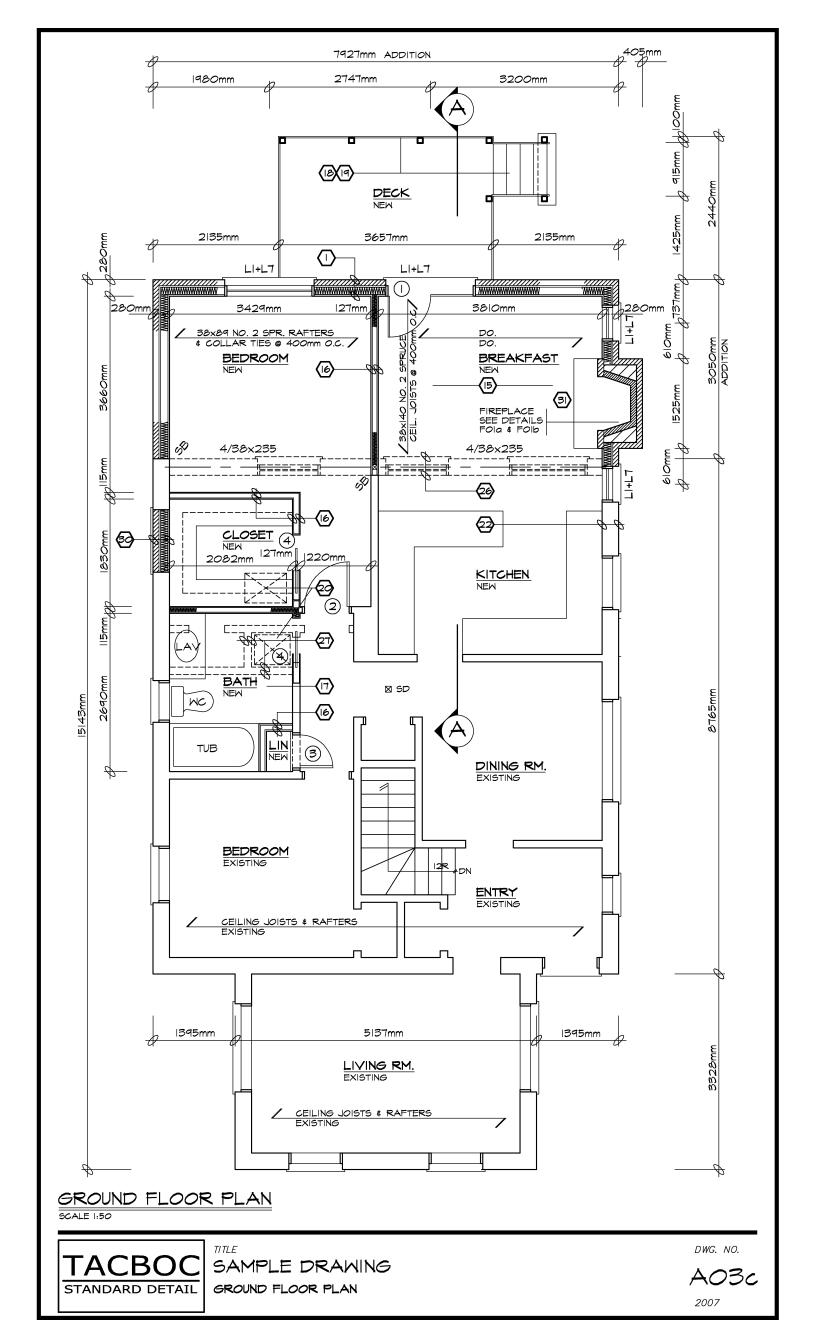




SAMPLE DRAMING

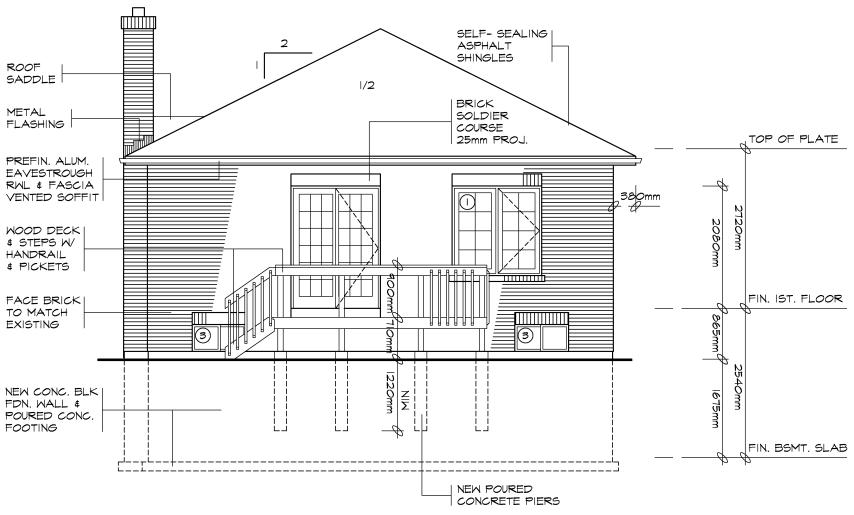


NORTH ELEVATION

SCALE 1:50



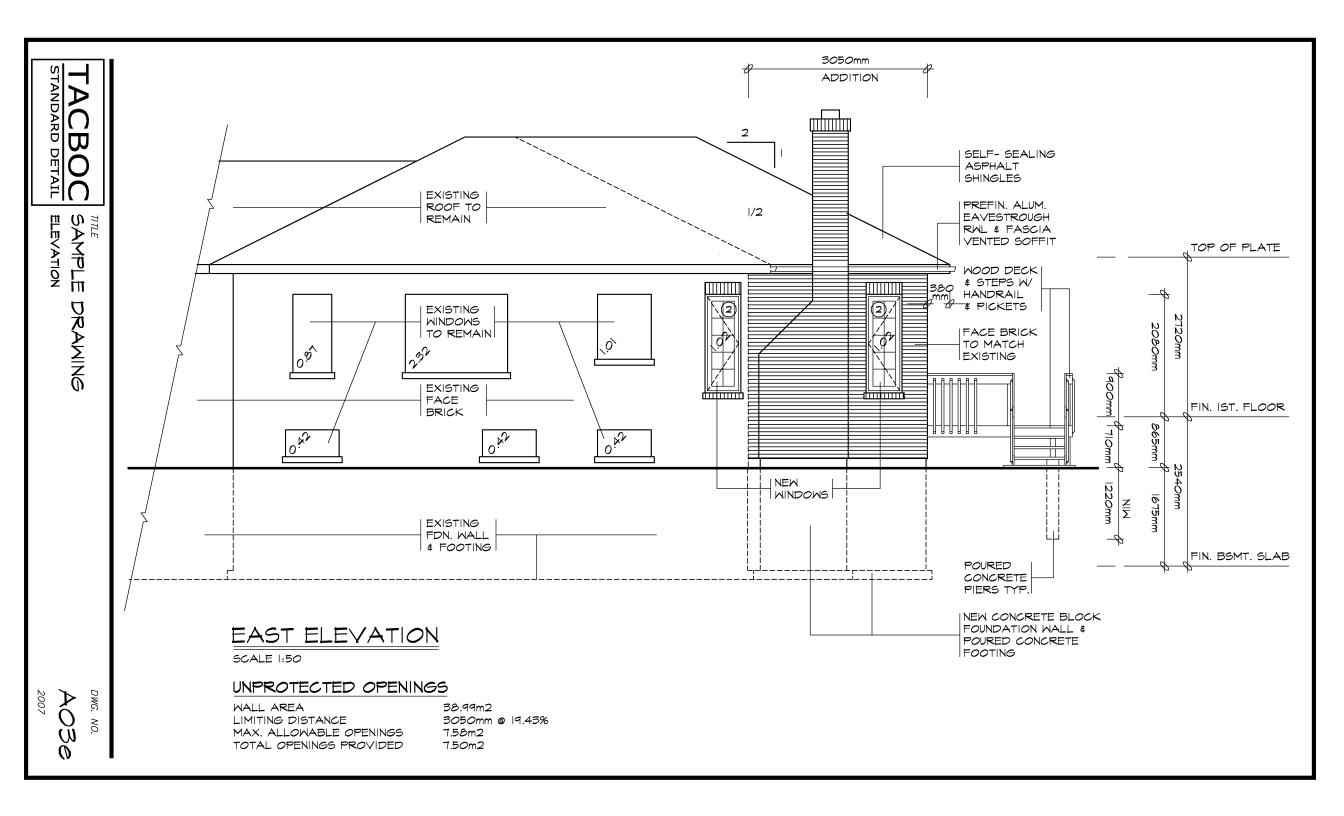


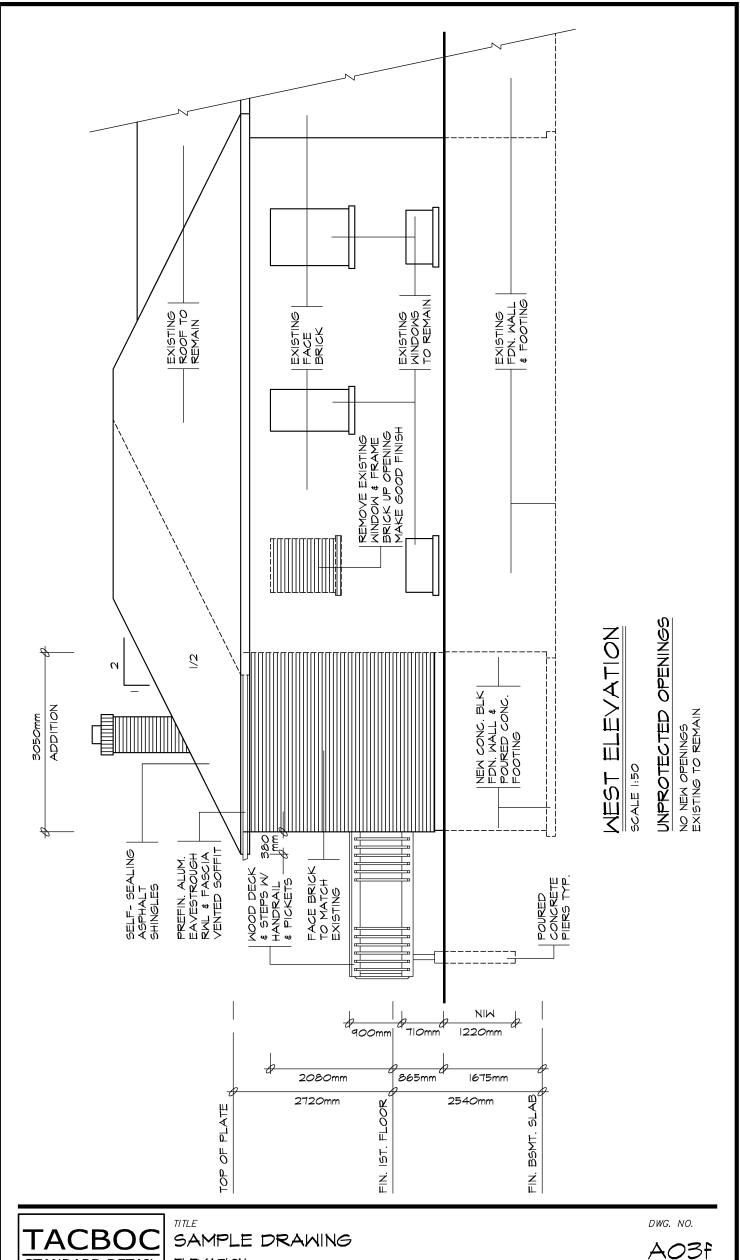

STANDARD DETAIL

ELEVATION



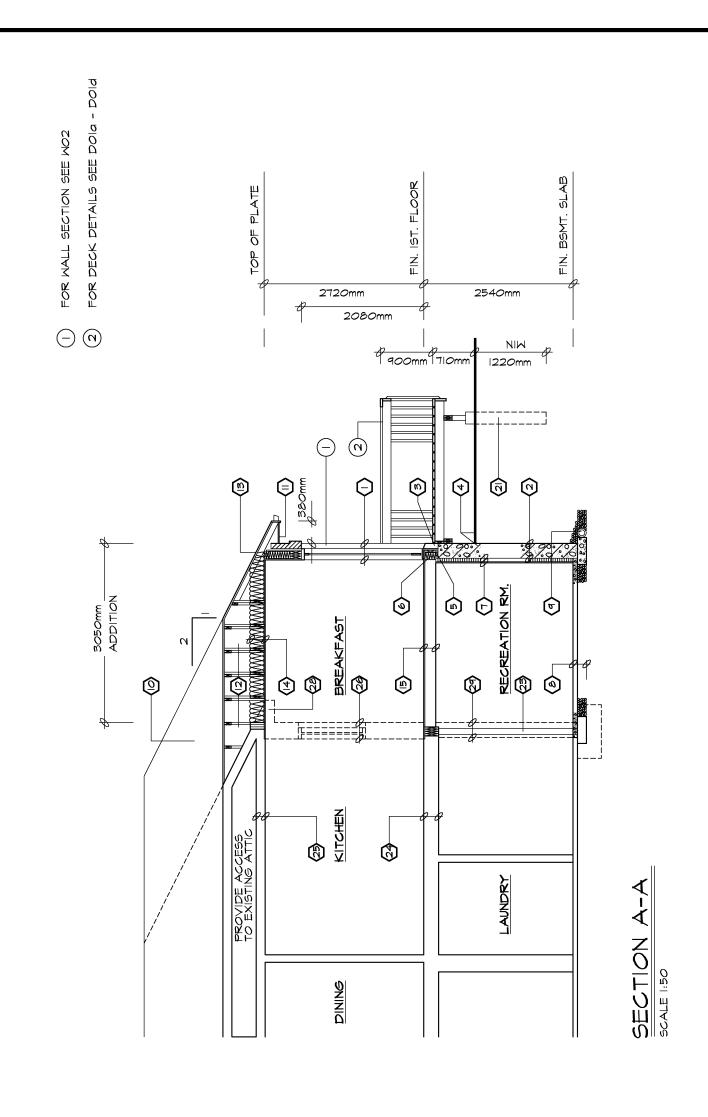



TITLE
SAMPLE DRAWING
CROSS SECTION

DWG. NO.



## CONSTRUCTION SPECIFICATIONS

 $\langle + 
angle$ brick veneer wall

90mm FACE BRICK, 25mm AIR SPACE O.76mm THICK × 22mm WIDE GALVANIZED METAL TIES INSTALLED W GALVANIZED SPIRAL NAILS OR SCREWS 400mm O.C. HORIZ., 600mm O.C. VERT. AIR BARRIER, LAYERS TO OVERLAP EACH OTHER
EXTERIOR TYPE SHEATHING
38x140 MOOD STUDS @ 400mm O.C.
RSI 3.34 BATT INSUL. IN CONTINUOUS
CONTACT W EXTERIOR SHEATHING CONTINUOUS AIR / VAPOUR BARRIER
12.7mm INTERIOR DRYWALL FINISH DOUBLE PLATE @ TOP SOLE PLATE @ BOTTOM

 $\langle z 
angle$ Foundation wall

BITUMINOUS DAMPPROOFING ON BITUMINOUS DAMPPROOFING ON
MINIMUM 6mm PARGING ON
CONCRETE BLOCK FDN. WALL
TOP BLOCK COURSE FILLED
W/ MORTAR OR CONCRETE
PROVIDE PARGING COVED OVER
450mmx150mm POURED CONC. FOOTING TO BEAR ON UNDISTURBED SOIL PROVIDE DRAINAGE LAYER

- MIN. 19mm MINERAL FIBRE INSULATION W/ A DENSITY OF
- NOT LESS THAN 57kg/m3. OR MIN. 100mm OF FREE DRAINING GRANULAR MATERIAL OR
- A B.M.E.C. APPROVED DRAINAGE LAYER MATERIAL

(3) BRICK VENEER @ FDN. WALL

0.5mm POLY FLASHING MINIMUM 150mm UP BEHIND SHEATHING PAPER WEEP HOLES @ MIN. 800mm APART

 $\langle 4 
angle$  grade

SLOPE GRADE AWAY FROM BUILDING FACE & PROVIDE SEMI-SOLID BLOCK COURSE AT OR BELOW GRADE LEVEL

(5)SILL PLATE

38×140 SILL PLATE FASTENED
TO FOUNDATION WALL WITH
MIN. 12.7mm DIA. ANCHOR BOLTS
EMBEDDED MIN. 100mm IN CONCRETE
© 2400mm O/C. MAX. \$ PROVIDE A CONTINUOUS AIR BARRIER BETWEEN
THE FOUNDATION WALL & WOOD FRAME CONSTRUCTION

(6) FLOOR INSULATION

CONTINUOUS HEADER JOIST WITH RSI 4.40 BATT INSULATION, EXTEND VAPOUR / AIR BARRIER & SEAL TO JOIST AND SUBFLOOR

7) FOUNDATION INSULATION

FOUNDATION WALL & WOOD FRAMING

(8) BASEMENT SLAB

75mm POURED CONCRETE SLAB (25 MPa CONC. STRENGTH) 100mm CRUSHED STONE BELOW

9 DRAINAGE

100mm DIA. WEEPING TILE W/ 150mm CRUSHED STONE COVER

(10) ROOF CONSTRUCTION

20 YEAR ASPHALT SHINGLES W/ EAVES PROTECTION ON MIN. 9.5mm EAVES PROTECTION ON MIN. 9.5MM
EXTERIOR PLYWOOD SHEATHING
ON APPROVED ROOF TRUSSES OR
CONVENTIONAL FRAMING (SEE PLANS)
USE 'H' CLIPS IF 600MM O.C. SPACING

(11)OVERHANG CONSTRUCTION

PREFINISHED ALUMINUM FASCIA, EAVESTROUGH & RAIN WATER LEADERS TO MATCH EXISTING FINISHES. PROVIDE DRIP EDGE AT FASCIA & VENTED SOFFIT EXTEND DOWNSPOUTS TO GRADE LEVEL

(12) ROOF VENTILATION

1:300 OF THE INSULATED CEILING AREA UNIFORMLY DISTRIBUTED.

(13) EAVES PROTECTION

EAVES PROTECTION MEMBRANE TO EXTEND FROM THE EDGE OF THE
ROOF, 900mm UP THE SLOPE BUT NOT
LESS THAN 300mm BEYOND THE
INTERIOR FACE OF THE EXTERIOR WALL

(14) CEILING CONSTRUCTION

15.9mm INTERIOR DRYWALL FINISH CONTINUOUS AIR / VAPOUR BARRIER W/ MINIMUM RSI 7.00 BATT INSULATION

(15) FLOOR CONSTRUCTION

15.5mm T&G PLYWOOD SUBFLOOR 38x184 FLOOR JOISTS @ 400mm O/C. FLOOR JOISTS BRIDGED W CONTINUOUS 19mmx64mm STRAPPING OR 2 ROWS OF 38mmx38mm CROSS BRIDGING OR SOLID BLOCKING

(16) INTERIOR STUD PARTITION

12.7mm DRYWALL FINISH BOTH SIDES OF 38x89 WOOD STUDS @ 400mm O/C 2 TOP PLATES & I BOTTOM PLATE PROVIDE REINFORCEMENT FOR FUTURE GRAB BAR INSTALLATION IN BATHROOM

(17) MECHANICAL VENTILATION

PROVIDE MIN. 10.6 CFM IN KITCHENS AND BATHROOMS, 80 CFM FOR PRINCIPAL EXHAUST FAN

(18) STAIRS INTERIOR/EXTERIOR

MAXIMUM RISE MINIMUM RISE 125mm MINIMUM RUN MAXIMUM RUN 210mm 355mm MINIMUM TREAD MAXIMUM TREAD MAXIMUM NOSING 235mm 355mm 25mm 860mm MINIMUM MIDTH MINIMUM HEADROOM 1950mm

(19) GUARDS

INTERIOR LANDINGS EXTERIOR BALCONY 1070mm INTERIOR STAIRS EXTERIOR STAIRS = 900mm MAX. BETWEEN PICKETS

GUARD HEIGHT IF DECK TO GRADE IS: GREATER THAN 1800mm = 1070mm 1800mm OR LESS
NO MEMBER OR ATTACHMENT BETWEEN 140mm & 900mm HIGH SHALL FACILITATE CLIMBING

PROVIDE ATTIC ACCESS MIN. 545mmx588mm W/ INSULATION & WEATHER STRIPPING

(21) PIERS

PROVIDE 184mm DIA. SONO TUBE FOR POURED CONCRETE PIERS MINIMUM 1200mm BELOW GRADE

22 EXISTING SOLID MASONRY EXTERIOR WALL TO REMAIN.

73mm DIA. PIPE COLUMN W/ IOOmmxIOOmmx6.35mm TOP & BOTTOM PLATE ImxImx450mm CONCRETE FOOTING

(24) EXISTING FLOOR STRUCTURE TO REMAIN.

(25) EXISTING CEILING STRUCTURE TO REMAIN.  $\langle 26 \rangle$  remove existing exterior wall

AS SHOWN DOTTED REMOVE EXISTING INTERIOR STUD PARTITIONS AS SHOWN DOTTED

(28) REMOVE EXISTING ROOF OVERHANG AS SHOWN DOTTED

 $\langle 29 
angle$  remove existing foundation wall AS SHOWN DOTTED

REMOVE EXISTING WINDOW & FRAME MAKE GOOD OPENING W/ BRICK TO MATCH EXISTING ON THE EXTERIOR

INSTALL A CARBON MONOXIDE DETECTOR CONFORMING TO CAN/CGA-6.19 OR UL 2034

IACBOO STANDARD DETAIL TITLE

SAMPLE DRAWING CONSTRUCTION SPECIFICATIONS DWG. NO.

RC	ROOM FINISH SCHEDULE										
RM. NO.	ROOM	FLOOR		BASE		WALLS		CEILING			REMARKS
	NO.	NAME	MATERIAL	FINISH	MATERIAL	FINISH	MATERIAL	FINISH	MATERIAL	FINISH	HEIGHT
	FIRST FLOOR										
<u>()</u>	KITCHEN	CERAMIC TILE		MOOD	PAINT	DRYWALL	PAINT	DRYWALL	PAINT	2720mm	
2	BREAKFAST	MOOD	STAIN	MOOD	PAINT	DRYWALL	PAINT	DRYWALL	PAINT	2720mm	MAPLE TO MATCH EXISTING
3	BEDROOM	MOOD	STAIN	MOOD	PAINT	DRYWALL	PAINT	DRYWALL	PAINT	2720mm	MAPLE TO MATCH EXISTING
4)	CLOSET	MOOD	STAIN	MOOD	PAINT	DRYWALL	PAINT	DRYWALL	PAINT	2720mm	MAPLE TO MATCH EXISTING
5.	BATH	CERAMIC TILE		MOOD	PAINT	DRYWALL	PAINT	DRYWALL	PAINT	2720mm	
	BASEMENT										
6	REC. ROOM	CONC.	CERAMIC TILE	MOOD	PAINT	DRYWALL	PAINT			2340mm	

D	DOOR SCHEDULE					
NO.	TYPE	SIZE	QTY.	REMARKS		
$\odot$	EXTERIOR	1525mmx 2030mm	1.	FRENCH DOOR		
2	SLAB	760mm× 2030mm	1.	800 SERIES		
3	SLAB	610mmx 2030mm	1.	800 SERIES		
4	POCKET DOOR	610mmx 2030mm	2.			

LII	LINTEL SCHEDULE						
NO.	DESCRIPTION						
<u>(1)</u>	2-38xi84 SPRUCE						
<b>(</b>	3-38x184 SPRUCE						
	2-38x235 SPRUCE						
<b>(4)</b>	3-38×235 SPRUCE						
	2-38x286 SPRUCE						
<b>(</b>	3-38x286 SPRUCE						
0	90mmx 90mmx 6mm L						
	90mmx 90mmx 8mm L						
9	100mmx 90mmx 6mm L						

ONE WINDOW PER FLOOR TO HAVE AN UNOBSTRUCTED OPEN PORTION W A MIN. AREA OF 0.35m2 W NO DIMENSION LESS THAN 380mm & MAXIMUM SILL HEIGHT OF IM ABOVE FLOOR						
NO.	TYPE	SIZE	QTY.	REMARKS		
<b>O</b>	CASEMENT	1525mm× 1525mm	1.			
2	CASEMENT	610mmx 1525mm	2.			
3	SLIDER	915mm× 450mm	2.			

## LEGEND

DUPLEX OUTLET (WEATHERPROOF)

DUPLEX OUTLET (HGT. ABOVE FLR.)

DUPLEX OUTLET (300mm ABOVE FLR.)

EXHAUST FAN

SWITCH

HB HOSE BIB

SD SMOKE DETECTOR

HEAVY DUTY OUTLET

LIGHT FIXTURE ( WALL MOUNTED )
LIGHT FIXTURE ( CEILING MOUNTED )

POT LIGHT FIXTURE

 $oldsymbol{\otimes}$  LIGHT FIXTURE ( WATER RESISTANT )

O LIGHT FIXTURE ( CAPPED )

FLUORESCENT LIGHT FIXTURE

SOLID WOOD BEARING

☐FD FLOOR DRAIN

■ TV CABLE OUTLET□ TELEPHONE OUTLET

© COMPUTER OUTLET

DE DRYER EXHAUST



NAMPLE DRAWING SCHEDULES



